
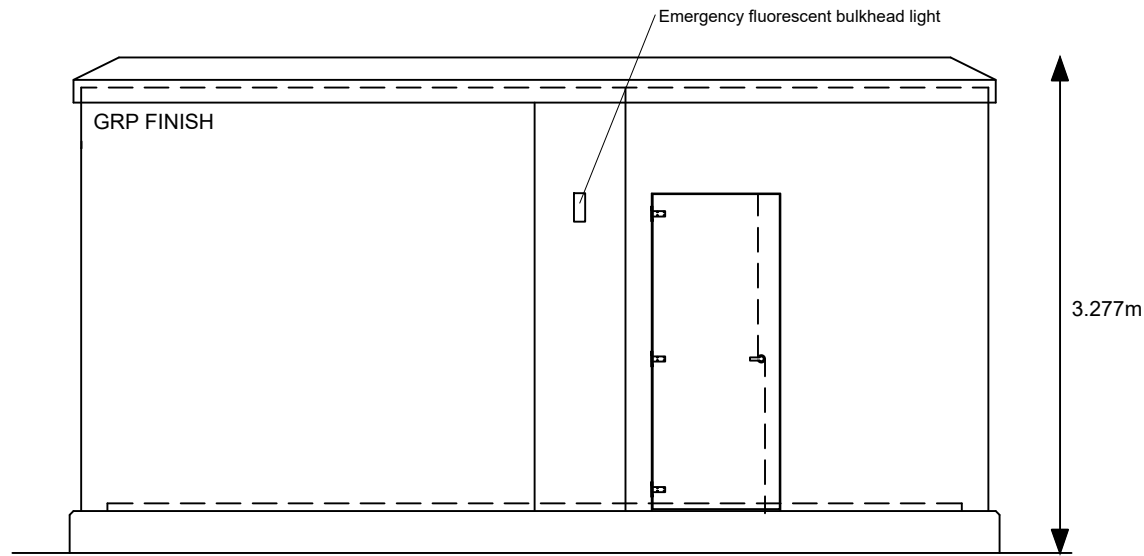


Notes: Unless otherwise stated, this drawing is for information only. Do not scale. Use figured dimensions only. Check all dimensions on site and advise of any discrepancies before commencing work on site.


Digital Transmissions: This data is supplied only as a means to aid you in the production of your work, the data should always be checked against the hard copy of the drawing. Some of the data may have been produced by imparting data from external sources, discrepancies may have occurred during this procedure. BSR cannot accept responsibility for any discrepancies within the CAD data file. No third party shall issue BSR data/drawings without the written approval of BSR. BSR check all data for viruses but cannot accept responsibility for any loss incurred by any third party as a result of installing data.

OS License No. :- 100022432


PLAN

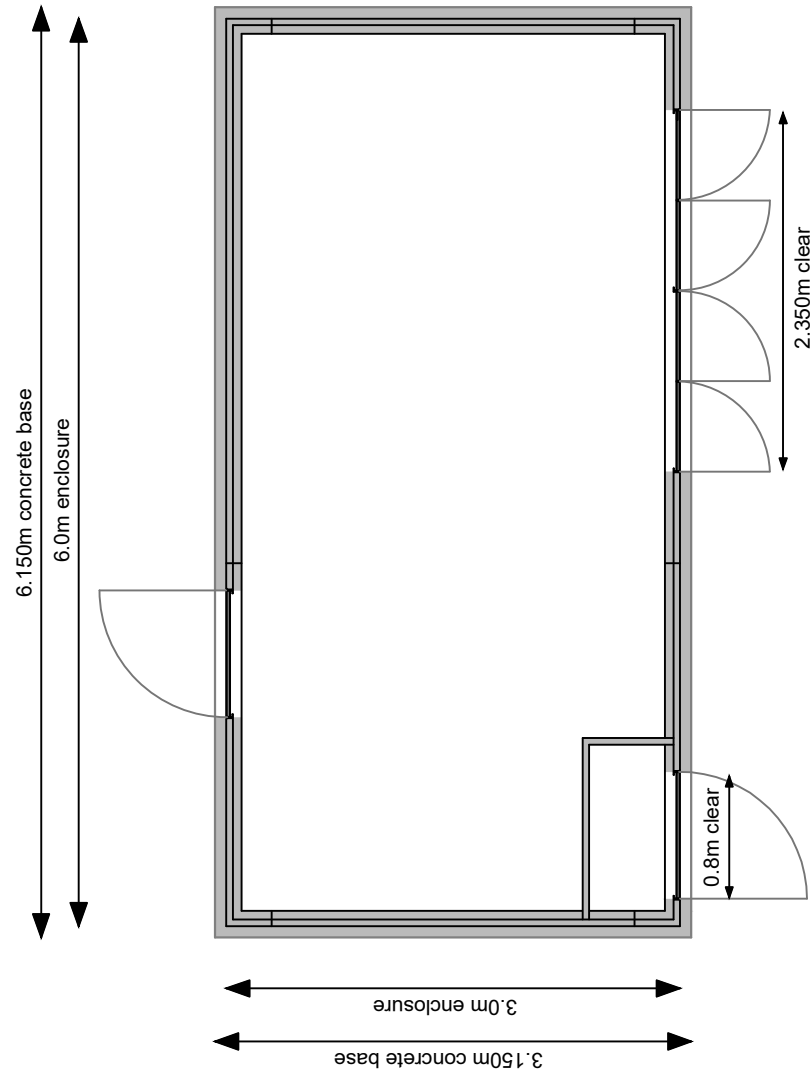


REAR ELEVATION

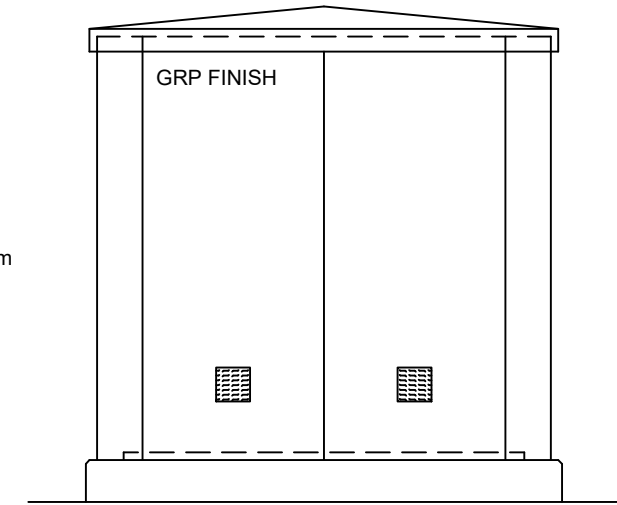

SIDE ELEVATION

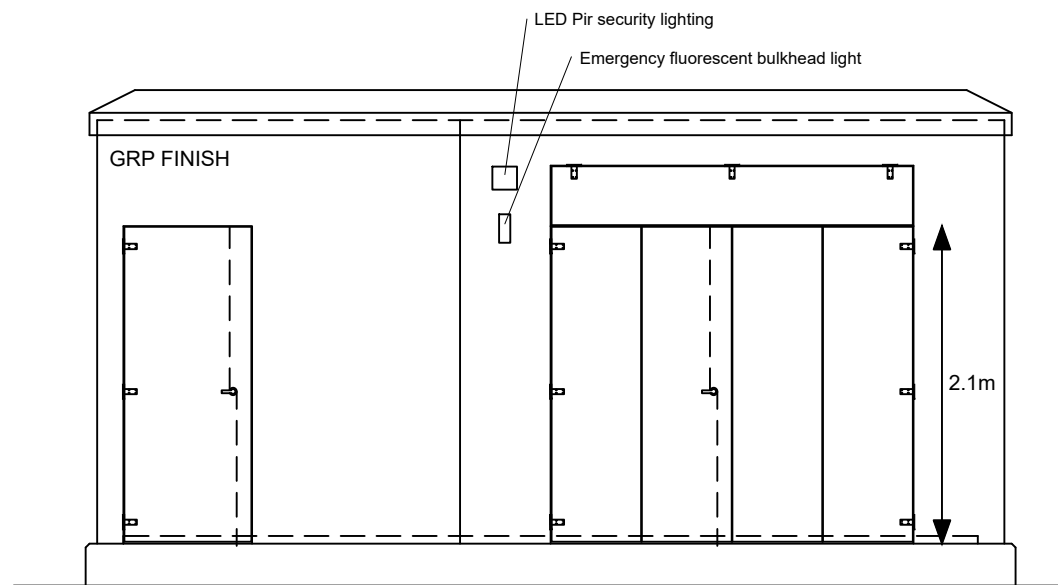

FRONT ELEVATION

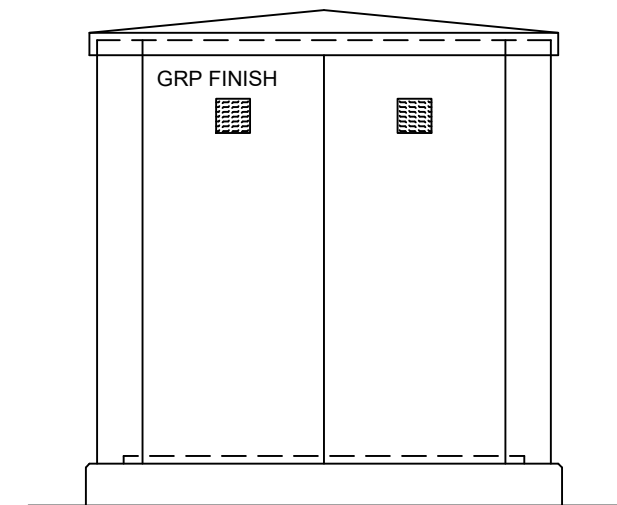

SIDE ELEVATION

Rev:	Revision History:	Date:	By:
01	Initial Issue	06.11.20	MB

35 and 35a The Mallings E:info@brillshrenewables.com
 Lower Charlton Trading Estate, T:01458 224900
 Shepton Mallet, W:www.brillshrenewables.com
 Somerset,BA4 5QE
 United Kingdom

Project:
 Rush Wall Solar Park

Location:
 South of Rushwall Lane
 Redwick
 Caldicot
 NP26 3DX

Title:
 33kV Private Switchgear

Scale: 1:50 @A3

Issue Notes:
 Initial Issue

Drawn By:
 MB Issue Date:
 06/10/20

Checked By:
 MB Checked Date:
 06/10/20

Approved By:
 RP Approved Date:
 15/11/21

Drawing Number:
 1578-0208-50

Drawing Status:
 Issued for Approval Issue:
 01

